

This drawing should not be scaled. Dimensions to be verified on site.
 Any discrepancies should be referred to the Engineer prior to work being put in hand.
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- NOTES:
- DO NOT SCALE. USE FIGURED DIMENSIONS ONLY.
 - THIS DRAWING IS TO BE READ IN CONJUNCTION WITH ALL OTHER RELEVANT ARCHITECTURAL AND ENGINEERING DRAWINGS.

PROPOSED RISING MAIN KEY PLAN
 SCALE 1:2000 @A1



PROPOSED DRAINAGE LAYOUT
 SCALE 1:500 @A1

LEGEND

- EXTENT OF WORKS
- PROPOSED uPVC FOUL WATER SEWER WITH PIPE SIZE, GRADE, MANHOLE REF. AND INVERT LEVEL
- PROPOSED SURFACE WATER SEWER WITH PIPE SIZE, GRADE, MANHOLE REF. AND INVERT LEVEL
- INDICATES PROPOSED ROAD GULLY AND CONNECTION
- INDICATES PROPOSED PERMEABLE PAVING
- PROPOSED STORM WATER HOUSE DRAIN AND ACCESS CHAMBER
- PROPOSED FOUL WATER HOUSE DRAIN AND ACCESS CHAMBER
- PROPOSED SINGLE WATER ACCESS CHAMBER & CONNECTION
- PROPOSED SOWKWAY WITH STORMTECH
- PROPOSED SOWKWAY WITH STONE
- PROPOSED SURFACE WATER SEWER WITH PIPE SIZE, GRADE, MANHOLE REF. AND INVERT LEVEL (CONCRETE SURROUNDING)
- INDICATES PROPOSED 1.35m DA SWS PIPE (BY OTHERS)
- INDICATES 4.0m WALKWAY FOR 1.35m DA SWS PIPE (BY OTHERS)
- INDICATES ASPHALT PETROL INTERCEPTOR

Rev	Date	Description	By	Chk
A	16/04/26	Layout Updates	SH	BG

Project: **KILDALKEY ROAD, TRIM, CO. MEATH**

Title: **PROPOSED DRAINAGE LAYOUT**

Client: **LOUGHLIN DEVELOPMENTS LIMITED**

Scale: @A1

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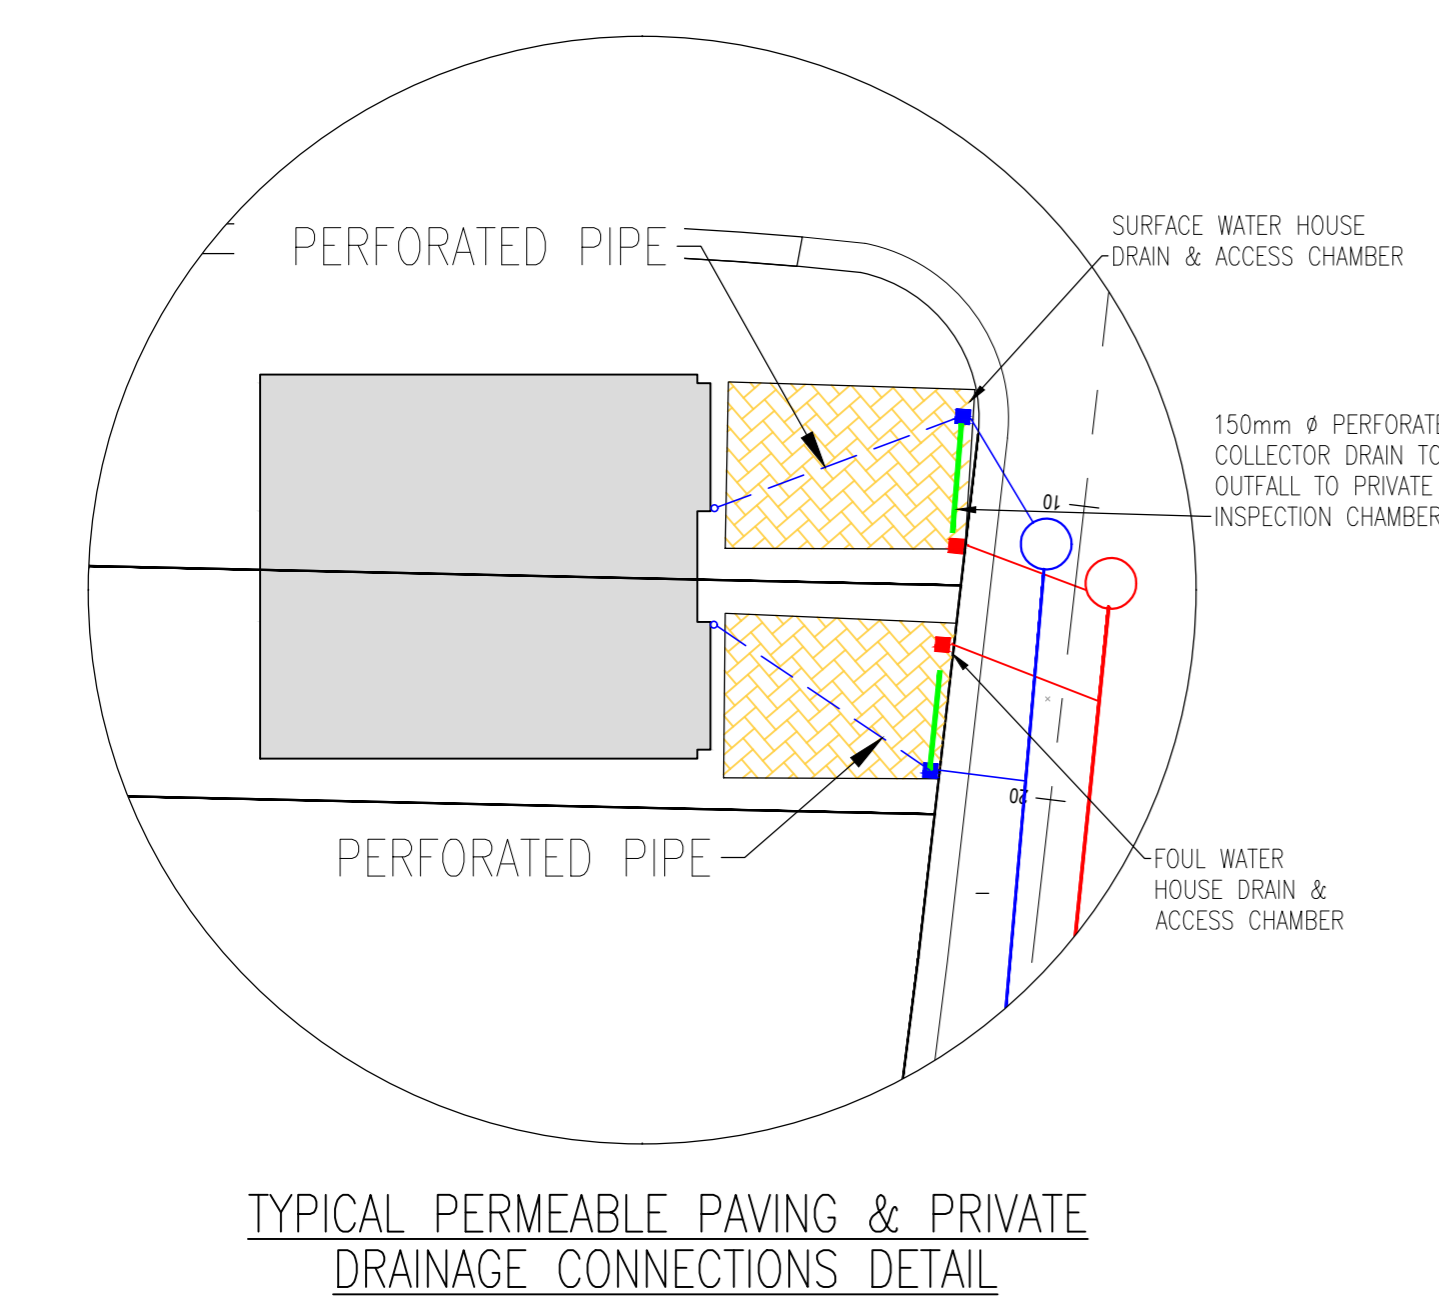
Status: **FOR PLANNING ONLY**

Designed By: **SK** Approved: **BG** Waterman Ref: **23-041**

Drawn By: **SH** Date: **NOV. 2025** AS SHOWN@A1

Project - Originator - Volume - Level - Type - Role - Number - Revision

TRIM - WAT - ZZ - XX-DR- C - P200 **A**



NOTE: CONTRACTOR TO CONFIRM POSITION AND INVERT OF ALL EXISTING SERVICES PRIOR TO COMMENCEMENT OF ANY WORKS. CONTRACTOR TO IMMEDIATELY INFORM ENGINEER IF ANY DISCREPANCIES ARE IDENTIFIED.

NOTE: FOR DETAILS OF INSTALLATION PLEASE REFER TO IRISH WATERS 'CODE OF PRACTICE FOR WASTEWATER INFRASTRUCTURE' & 'WASTEWATER INFRASTRUCTURE STANDARD DETAILS'

NOTE: PUBLIC FOUL PIPE MATERIAL TO BE U-PVC (STIFFNESS CLASS 8) AND IN COMPLIANCE WITH SECTION 3.13 OF IRISH WATER CODE OF PRACTICE.

NOTE: FOUL SEWERS TO BE CONSTRUCTED WITH CONCRETE SURROUNDING IN ACCORDANCE WITH IRISH WATER STD-WW-08 WHERE VERTICAL CLEARANCE FROM SURFACE WATER IS LESS THAN 300mm AND WHERE DEPTH OF COVER TO ROAD IS LESS THAN 1.2m

